# DOUBLE STOREY HOUSE WITH BASEMENT CARPARKING

# JOYCE NGUYET HANG

# LOT 8 DP 13832, 7 CRAGG ST, CONDELL PARK


# CANTEBURY BANKSTOWN COUNCIL

DRAWING LIST

LAYOUT NO.	DRAWING TITLE
01	COVER PAGE
02	SITE PLAN
03	BASEMENT FLOOR PLAN
04	GROUND FLOOR PLAN
05	FIRST FLOOR PLAN
06	ROOF PLAN
07	ELEVATIONS
08	ELEVATIONS / BASIX
09	SECTIONS
10	WINDOW SCHEDULE
11	MATERIAL / FINISHES
12	9AM SHADOW DIAGRAM 21 JUNE
13	12PM SHADOW DIAGRAM 21 JUNE
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15	DEMOLITION PLAN
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17	SITE ANALYSIS PLAN
18	EROSION / SEDIMENT CONTROL
19	WASTE MANAGEMENT PLAN
20	NOTIFICATIONS - SITE PLAN
21	NOTIFICATIONS / ELEVATIONS


DATE	DESCRIPTION	REV
27/04/2022	DEVELOPMENT APPLICATION	А



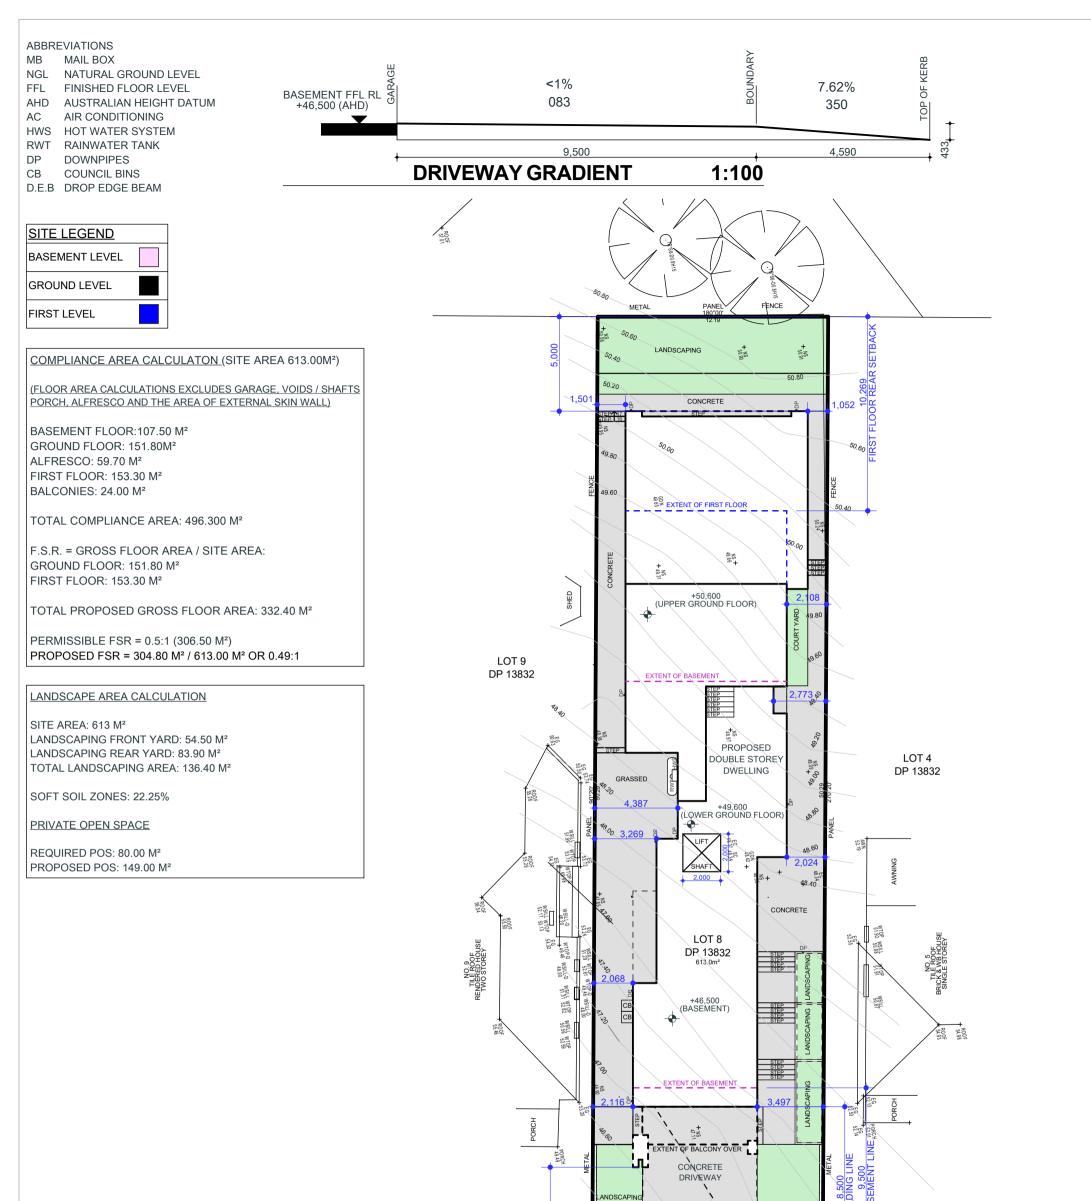



	GENERAL NOTES: DO NOT SCALE DRAWINGS, USE FIGURED DIMENSIONS ONLY. CONFIRM DIMENSIONS AND LEVELS PRIOR TO THE COMMENCEMENT OF ANY	GENERAL NOTES 1. LIFT OFF HINGES TO ALL BATHROOM DOORS. 2. ALL MECHANICAL VENTILATION TO BE DUCTED.	FILLS	PROJECT DETAILS		DESIGNED: AO	CHECKED: AO		
	WORK. DISCREPANCIES MUST BE BROUGHT TO THE ATTENTION OF THIS FIRM	3. RANGEHOOD TO BE DUCTED EXTERNALLY.     4. ALL SQUARE SET OPENINGS FOR 2.4M CEILINGS TO BE 2.1M IN HEIGHT.	3. RANGEHOOD TO BE DUCTED EXTERNALLY. 4. ALL SQUARE SET OPENINGS FOR 2.4M CEILINGS TO BE 2.1M IN HEIGHT. S	3. RANGEHOOD TO BE DUCTED EXTERNALLY.	ANGEHOOD TO BE DUCTED EXTERNALLY. PROPOSED: DOUBLE S LI SQUARE SET OPENINGS FOR 2.4M CEILINGS TO BE 2.1M IN HEIGHT. STEEL BEAM	PROPOSED: DOUBLE STOREY HOUSE WITH BASEMENT CARPARKING	DRAW		DATE: 27/04/2022
	THIS DRAWING. ALL WORK IS TO BE CARRIED OUT AS PER APPROVED PLANS IN ACCORDANCE WITH THE BCA AND RELEVANT CONSENT AUTHORITY CONDITIONS.	6. ALL WINDOWS SET TO 2400mm HEAD HEIGHT UNLESS STATED OTHERWISE. 7. PROVIDE A 25mm MINIMUM RECESS IN CONCRETE SLAB FOR ALL WET AREAS. 8. ALL SHOWER NICHE TO BE 600mm X 600mm IN DIMENSIONS AT 1200mm FFL UNLESS		CLIENT NAME: JOYCE NGUYET HANG	$\bigcirc$	SCALE: 1:200	DRAWING NO: 02		
	COPYRIGHT CLAUSE: THE DESIGN AND DETAILS CONTAINED ON THIS DRAWING IS	STATED OTHERWISE. 9. HARD WIRED PHOTO-ELECTRIC SMOKE ALARMS TO BE INSTALLED IN ACCORDANCE	TU 50	ADDRESS: 7 CRAGG ST, CONDELL PARK	Z	TITLE: SITE			
ONE OF ONE DESIGN	SUBJECT TO COPYRIGHT LAWS AND IS SUPPLIED IN CONFIDENCE THAT IT IS NOT TO BE USED FOR ANY OTHER PURPOSE EXCEPT THAT AUTHORISED BY THIS FIRM -	WITH NCC PART 3.7.5 & AS 3786. 10. EXHAUST SYSTEMS INSTALLED IN THE KITCHEN, BATHROOM, SANITARY COMPARTMENTS OR LAUNDRY MUST COMPLY WITH MINIMUM FLOW RATES AS		DP NO: 13832		IIILE. SIIL	FLAN		
	THE LEGAL AND BENEFICIAL OWNER.	SPECIFIED IN NCC PART 3.8.7.3. BATHROOM, SANITARY COMPARTMENTS & LAUNDRIES MUST BE DISCHARGED DIRECTLY VIA SHAFT OR DUCT TO OUTDOOR AIR OR TO A VENTILATED ROOF SPACE COMPLYING WITH NCC PART 3.8.7.4		COUNCIL: CANTEBURY BANKSTOWN COUNCIL					

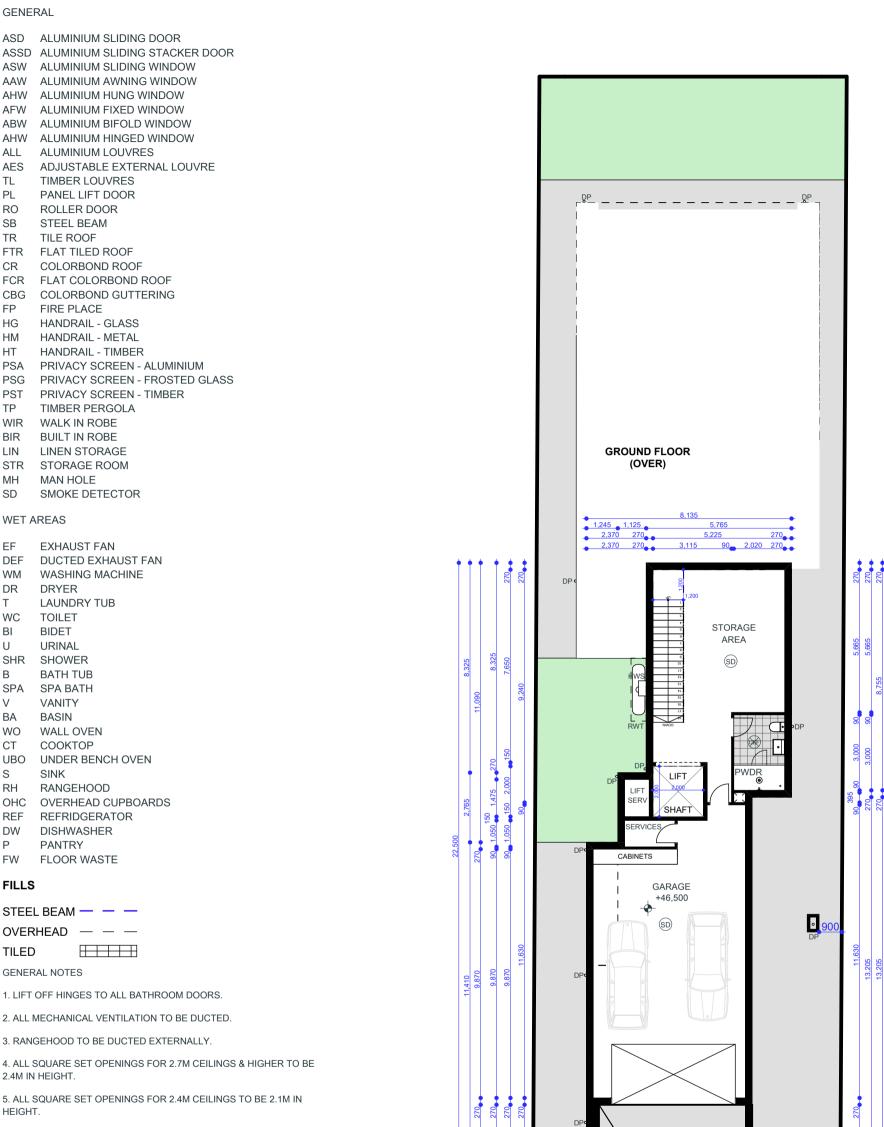

6. ALL INTERNAL DOORS TO BE 2400mm IN HEIGHT UNLESS STATED OTHERWISE.


7. ALL WINDOWS SET TO 2400mm HEAD HEIGHT UNLESS STATED OTHERWISE.

8. PROVIDE A 25mm MINIMUM RECESS IN CONCRETE SLAB FOR ALL WET AREAS.

9. ALL SHOWER NICHE TO BE 600mm X 600mm IN DIMENSIONS AT 1200mm FFL UNLESS STATED OTHERWISE.

10. HARD WIRED PHOTO-ELECTRIC SMOKE ALARMS TO BE INSTALLED IN ACCORDANCE WITH NCC PART 3.7.5 & AS 3786.

11. EXHAUST SYSTEMS INSTALLED IN THE KITCHEN, BATHROOM, SANITARY COMPARTMENTS OR LAUNDRY MUST COMPLY WITH MINIMUM FLOW RATES AS SPECIFIED IN NCC PART 3.8.7.3. BATHROOM, SANITARY COMPARTMENTS & LAUNDRIES MUST BE DISCHARGED DIRECTLY VIA SHAFT OR DUCT TO OUTDOOR AIR OR TO A VENTILATED ROOF SPACE COMPLYING WITH NCC PART 3.8.7.4

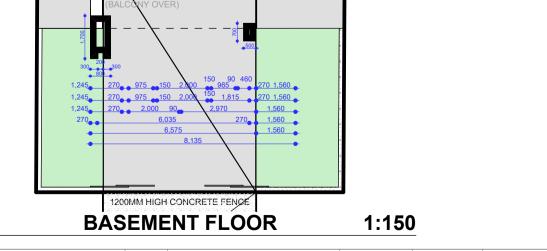



### 9,640 GENERAL 270 270 9,100 ALFRESCO 270\_\_\_ 270 1,110 ASD ALUMINIUM SLIDING DOOR 7,990 KITCHEN / FAMILY 270 90 2,435 270 1,110 WC / LAUNDRY ASSD ALUMINIUM SLIDING STACKER DOOR 5,465 KITCHEN 270 90 1,735 270 700 1,110 ASW ALUMINIUM SLIDING WINDOW 5,465 AAW ALUMINIUM AWNING WINDOW AHW ALUMINIUM HUNG WINDOW ONGITUDINAL SECT ALUMINIUM FIXED WINDOW AFW LANDSCAPING ALUMINIUM BIFOLD WINDOW ABW ALUMINIUM HINGED WINDOW AHW ALL ALUMINIUM LOUVRES AES ADJUSTABLE EXTERNAL LOUVRE ΤL TIMBER LOUVRES PL PANEL LIFT DOOR RO ROLLER DOOR SINK SB STEEL BEAM DW TR **TILE ROOF** FTR FLAT TILED ROOF CR COLORBOND ROOF W08 FCR FLAT COLORBOND ROOF CBG COLORBOND GUTTERING CONCRE<sup>-</sup> FP FIRE PLACE 9,135 LFRES SOS OPENING HG HANDRAIL - GLASS HANDRAIL - METAL HM ΗT HANDRAIL - TIMBER PRIVACY SCREEN - ALUMINIUM PSA ALFRESCO PRIVACY SCREEN - FROSTED GLASS PSG PST **PRIVACY SCREEN - TIMBER** CONCRETE TΡ TIMBER PERGOLA WIR WALK IN ROBE SD02 STEP STEP **BUILT IN ROBE** BIR 2 LIN LINEN STORAGE STR STORAGE ROOM SD03 YARD MH MAN HOLE 单 SMOKE DETECTOR SD SD KITCH FAMILY 5,245 TCHE 5,245 ō WET AREAS +50,600 4 Кþ EXHAUST FAN EF DEF DUCTED EXHAUST FAN WASHING MACHINE WM DP DRYER DR 1.475 1,475 WC LAUNDRY TUB Т 8 WC W06 TOILET W.I.P BI BIDET 1,460 ,460 URINAL U STEP SHOWER SHR 270 (W05) SD В BATH TUB ()×C SPA SPA BATH 2.600 ALINDRY LDRY V VANITY 4,545 8 2 BA BASIN WO WALL OVEN W13 +49,600 LANDSCAPING W04 СТ COOKTOP • ENTRY UBO UNDER BENCH OVEN W14 3.605 ENTRY S SINK LIFT RANGEHOOD RH 475 OVERHEAD CUPBOARDS OHC SHAFT REF REFRIDGERATOR 0 DW DISHWASHER ENS ۲ Ρ PANTRY **J**AC N. FW FLOOR WASTE CONCRETE GUEST BED FILLS CONCRETE 3,500 GUEST F STEEL BEAM — — — OVERHEAD \_ \_ \_ SD 8 TILED DF B.I.R 2,010 **GENERAL NOTES** DP CABINETS 1. LIFT OFF HINGES TO ALL BATHROOM DOORS. SS SECTION LANDSCAPING +49,600 6 2. ALL MECHANICAL VENTILATION TO BE DUCTED. S SECTION LIVING 3. RANGEHOOD TO BE DUCTED EXTERNALLY. W01 4. ALL SQUARE SET OPENINGS FOR 2.7M CEILINGS & HIGHER TO BE 2.4M IN HEIGHT 5. ALL SQUARE SET OPENINGS FOR 2.4M CEILINGS TO BE 2.1M IN

## **ABBREVIATIONS**

7. ALL WINDOWS SET TO 2400mm HEAD HEIGHT UNLESS STATED OTHERWISE

6. ALL INTERNAL DOORS TO BE 2400mm IN HEIGHT UNLESS STATED

HEIGHT.

OTHERWISE.

8. PROVIDE A 25mm MINIMUM RECESS IN CONCRETE SLAB FOR ALL WET AREAS.


9. ALL SHOWER NICHE TO BE 600mm X 600mm IN DIMENSIONS AT 1200mm FFL UNLESS STATED OTHERWISE.

10. HARD WIRED PHOTO-ELECTRIC SMOKE ALARMS TO BE INSTALLED IN ACCORDANCE WITH NCC PART 3.7.5 & AS 3786

ONE OF ONE DESIGN

11. EXHAUST SYSTEMS INSTALLED IN THE KITCHEN, BATHROOM. SANITARY COMPARTMENTS OR LAUNDRY MUST COMPLY WITH MINIMUM FLOW RATES AS SPECIFIED IN NCC PART 3.8.7.3. BATHROOM, SANITARY COMPARTMENTS & LAUNDRIES MUST BE DISCHARGED DIRECTLY VIA SHAFT OR DUCT TO OUTDOOR AIR OR TO A VENTILATED ROOF SPACE COMPLYING WITH NCC PART 3.8.7.4

THE LEGAL AND BENEFICIAL OWNER.

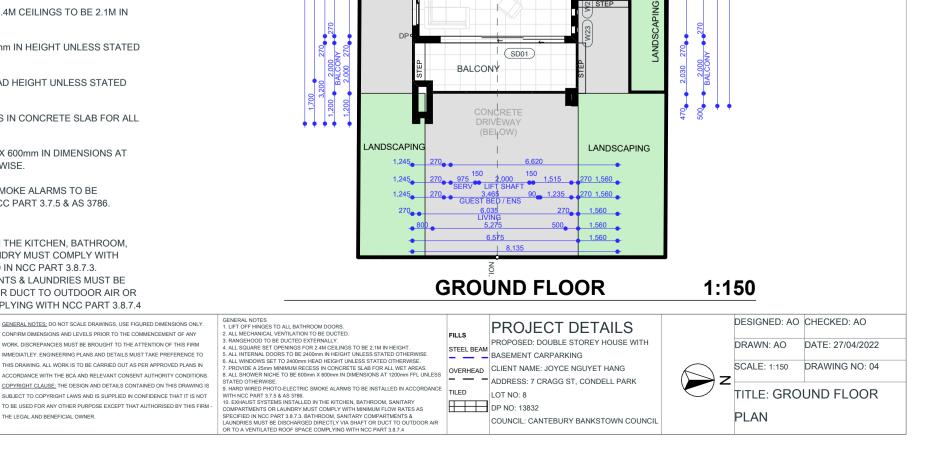

DP

ABBREVIATIONS		8,530
GENERAL		270         3.950         90         3.950         270           BED 3         BED 2         BED 2         270         2.950         90         1.910         90         2.950         270
ASDALUMINIUM SLIDING DOORASSDALUMINIUM SLIDING STACKER DOORASWALUMINIUM SLIDING WINDOWAAWALUMINIUM AWNING WINDOWAHWALUMINIUM HUNG WINDOWAFWALUMINIUM FIXED WINDOWABWALUMINIUM BIFOLD WINDOWAHWALUMINIUM HINGED WINDOWAHWALUMINIUM HINGED WINDOWALUMINIUM HINGED WINDOWALUMINIUM HINGED WINDOWALLALUMINIUM LOUVRES		270 2.850 90 4.950 D.1.K 270 WC RUMPUS 1.450 270 2.800 90 3.650 270 BATH RUMPUS 90 480 270 BATH RUMPUS 90 480 270 SERV UN VIEW VIEW VIEW VIEW VIEW VIEW VIEW VIEW
AES ADJUSTABLE EXTERNAL LOUVRE TL TIMBER LOUVRES		L LON
PL PANEL LIFT DOOR RO ROLLER DOOR SB STEEL BEAM TR TILE ROOF		
FTR FLAT TILED ROOF		••••••••••••••••••••••••••••••••••••••
CR COLORBOND ROOF FCR FLAT COLORBOND ROOF		
CBG COLORBOND GUTTERING		
FP     FIRE PLACE       HG     HANDRAIL - GLASS		
HM HANDRAIL - METAL	405	
HT HANDRAIL - TIMBER PSA PRIVACY SCREEN - ALUMINIUM	40	3 31
PSG PRIVACY SCREEN - FROSTED GLASS		
PST PRIVACY SCREEN - TIMBER TP TIMBER PERGOLA	4.560 BED 3 .880	BED 3 BED 2 STEP 9 3 4 5 6 6 7 6 7 6 7 6 7 6 7 6 7 6 7 6 7 6 7
WIR WALK IN ROBE	4,6	BE155
BIR BUILT IN ROBE LIN LINEN STORAGE	8	
STR STORAGE ROOM		
MH MAN HOLE SD SMOKE DETECTOR	1.200 WC	B.I.R 555 555 8 B.I.R 555 555 555 555 555 555 555 555 555 5
WET AREAS	5 5	W27 W27 W27 W27 W27 W27 W27 W27
EF EXHAUST FAN	) 3.570 8ATH 2.885 BATH	
DEF DUCTED EXHAUST FAN WM WASHING MACHINE	4,580 B3	
DR DRYER		DP ● ● ● FFL P P P P P P P P P P P P P P P P P P
T LAUNDRY TUB WC TOILET	SERV SERV	
BI BIDET		3,055 <b>5 beg FALL</b> (AHD)
U URINAL SHR SHOWER	25,115 27	STEP 10 DEG
B BATH TUB	7,065	
SPA SPA BATH V VANITY	5.885	
BA BASIN		
WO WALL OVEN CT COOKTOP		
UBO UNDER BENCH OVEN	84.720 270 FT 150	
S SINK RH RANGEHOOD		
OHC OVERHEAD CUPBOARDS	) 1:475 SERV 2:00 LIFT SH	
REF REFRIDGERATOR DW DISHWASHER	1.100 <sup>150</sup>	
P PANTRY		
FW FLOOR WASTE	7.60 NS	
FILLS	2,440 1 1	2 DEG
STEEL BEAM — — —		
OVERHEAD — — —	ଟି ଚି	
	3.110 W.I.R 3.110	
GENERAL NOTES	3 3 3 3	
1. LIFT OFF HINGES TO ALL BATHROOM DOORS.	S S CF	
2. ALL MECHANICAL VENTILATION TO BE DUCTED.		FFL RL
3. RANGEHOOD TO BE DUCTED EXTERNALLY.	6.540 6.000 1 EBED	+52,950 (AHD)
4. ALL SQUARE SET OPENINGS FOR 2.7M CEILINGS & HIGHER TO BE 2.4M IN HEIGHT.	6.540 6.000 MASTER BED 5.000 MASTER BED 5.000	The second secon
5. ALL SQUARE SET OPENINGS FOR 2.4M CEILINGS TO BE 2.1M IN HEIGHT.	270	2,106 DP
6. ALL INTERNAL DOORS TO BE 2400mm IN HEIGHT UNLESS STATED OTHERWISE.	500 500 270 270	

7. ALL WINDOWS SET TO 2400mm HEAD HEIGHT UNLESS STATED OTHERWISE.


8. PROVIDE A 25mm MINIMUM RECESS IN CONCRETE SLAB FOR ALL WET AREAS.

9. ALL SHOWER NICHE TO BE 600mm X 600mm IN DIMENSIONS AT 1200mm FFL UNLESS STATED OTHERWISE.

10. HARD WIRED PHOTO-ELECTRIC SMOKE ALARMS TO BE INSTALLED IN ACCORDANCE WITH NCC PART 3.7.5 & AS 3786.

11. EXHAUST SYSTEMS INSTALLED IN THE KITCHEN, BATHROOM, SANITARY COMPARTMENTS OR LAUNDRY MUST COMPLY WITH MINIMUM FLOW RATES AS SPECIFIED IN NCC PART 3.8.7.3. BATHROOM, SANITARY COMPARTMENTS & LAUNDRIES MUST BE DISCHARGED DIRECTLY VIA SHAFT OR DUCT TO OUTDOOR AIR OR TO A VENTILATED ROOF SPACE COMPLYING WITH NCC PART 3.8.7.4

THE LEGAL AND BENEFICIAL OWNER.

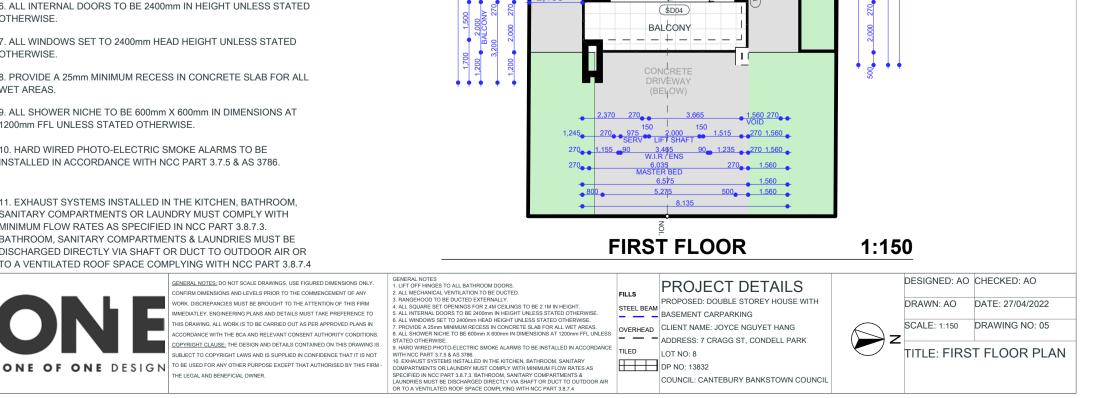

# ABBREVIATIONS

## GENERAL

GENEI	RAL
ASD	ALUMINIUM SLIDING DOOR
	ALUMINIUM SLIDING STACKER DOOR
	ALUMINIUM SLIDING WINDOW
	ALUMINIUM AWNING WINDOW
	ALUMINIUM HUNG WINDOW
AES	ADJUSTABLE EXTERNAL LOUVRE
TL PL	TIMBER LOUVRES
	PANEL LIFT DOOR
RO SB	ROLLER DOOR STEEL BEAM
TR FTR	TILE ROOF FLAT TILED ROOF
CR	COLORBOND ROOF
	FLAT COLORBOND ROOF
	COLORBOND GUTTERING
CBG FP	FIRE PLACE
• •	
HG HM	HANDRAIL - GLASS HANDRAIL - METAL
HIM	HANDRAIL - METAL HANDRAIL - TIMBER
	PRIVACY SCREEN - ALUMINIUM
	PRIVACY SCREEN - ALOMINIOM PRIVACY SCREEN - FROSTED GLASS
	PRIVACY SCREEN - TIMBER
TP	TIMBER PERGOLA
WIR	WALK IN ROBE
BIR	BUILT IN ROBE
LIN	LINEN STORAGE
STR	STORAGE ROOM
MH	MAN HOLE
SD	SMOKE DETECTOR
WET A	REAS
EF	EXHAUST FAN
DEF	DUCTED EXHAUST FAN
WM	WASHING MACHINE
DR	DRYER
T	LAUNDRY TUB
WC	TOILET
BI	BIDET
U	URINAL
SHR	SHOWER
B	BATH TUB
SPA	SPA BATH
V	VANITY
BA	BASIN
WO	WALL OVEN
CT	COOKTOP
UBO	UNDER BENCH OVEN
S	SINK
RH	RANGEHOOD
ОНС	OVERHEAD CUPBOARDS
REF	REFRIDGERATOR
DW	DISHWASHER
Р	PANTRY
FW	FLOOR WASTE
FILLS	
STEEI	_ BEAM — — —
OVER	HEAD — — —
TILED	
GENER	AL NOTES

1. LIFT OFF HINGES TO ALL BATHROOM DOORS.


2. ALL MECHANICAL VENTILATION TO BE DUCTED.

3. RANGEHOOD TO BE DUCTED EXTERNALLY.

4. ALL SQUARE SET OPENINGS FOR 2.7M CEILINGS & HIGHER TO BE 2.4M IN HEIGHT.

5. ALL SQUARE SET OPENINGS FOR 2.4M CEILINGS TO BE 2.1M IN HEIGHT.

6. ALL INTERNAL DOORS TO BE 2400mm IN HEIGHT UNLESS STATED OTHERWISE.

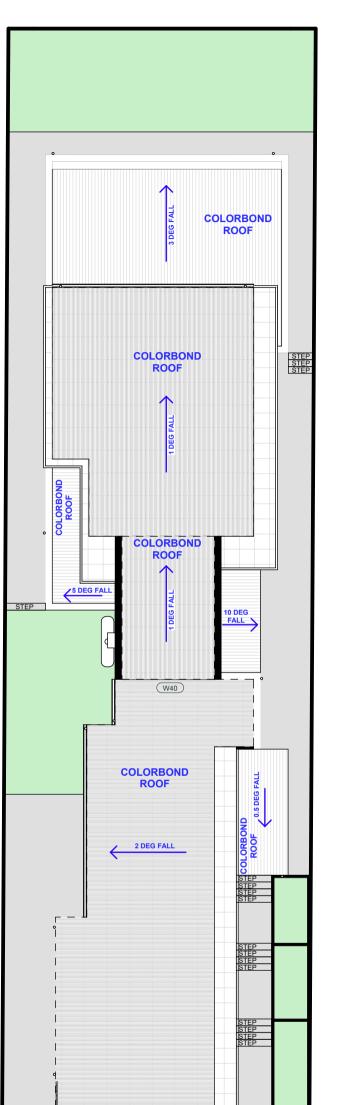


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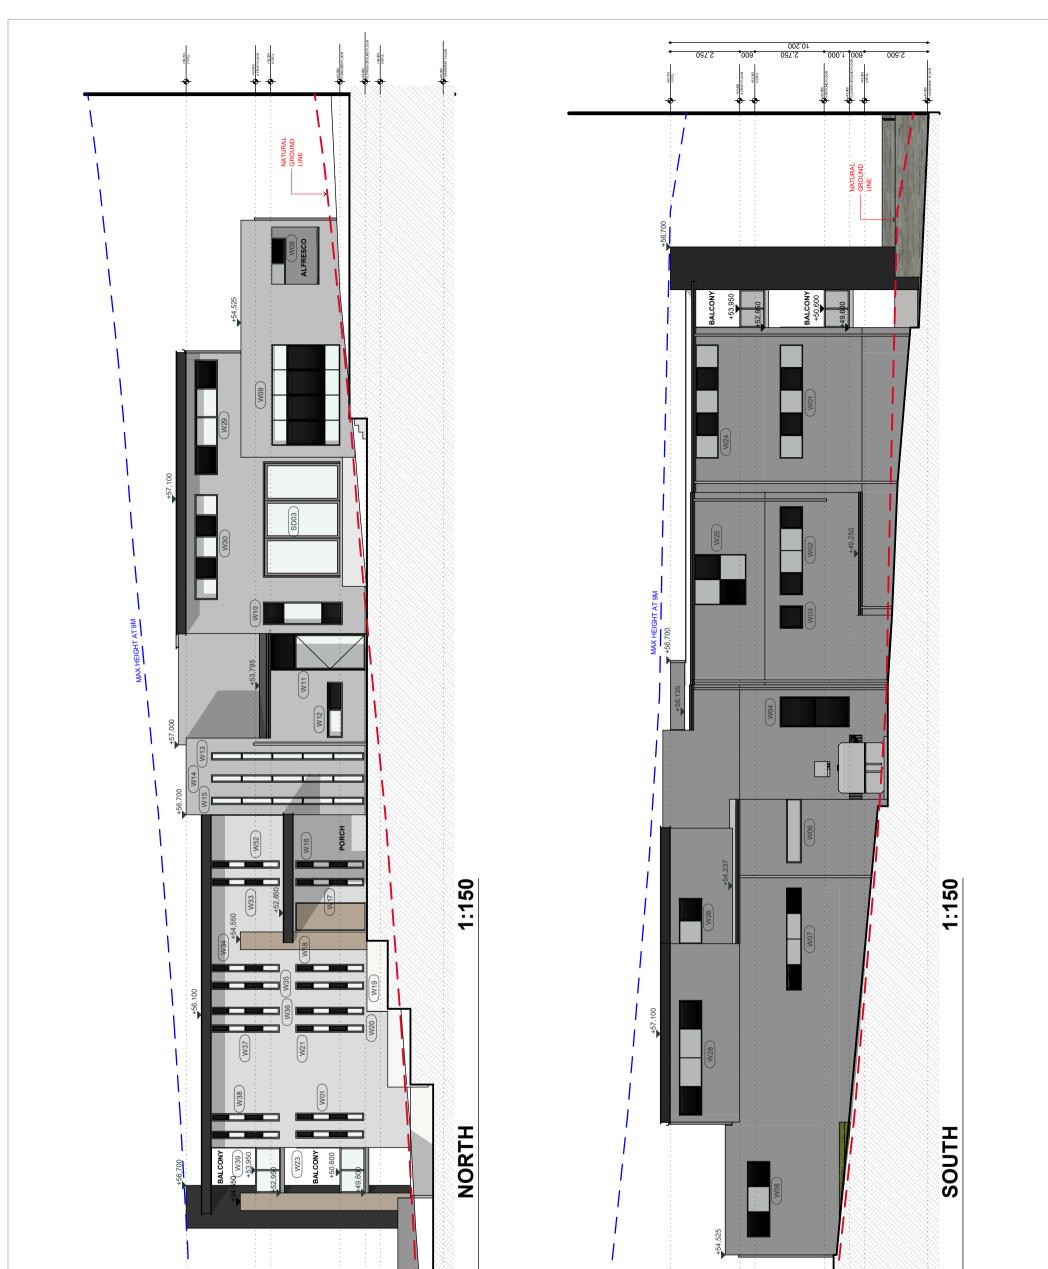
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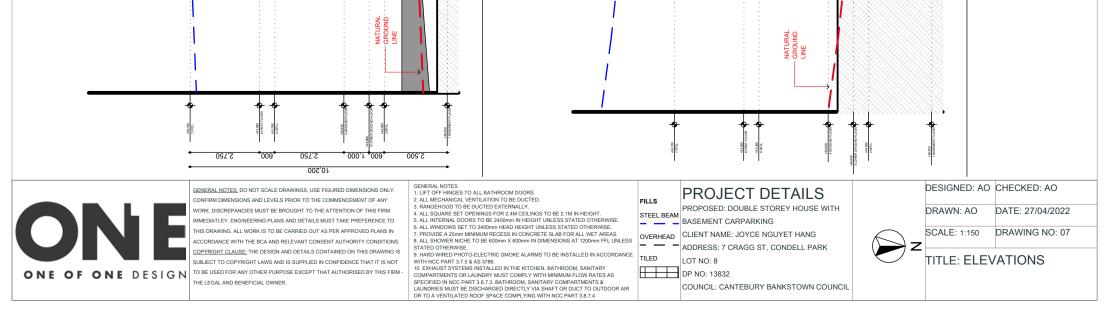


ROOF PLAN

1:150





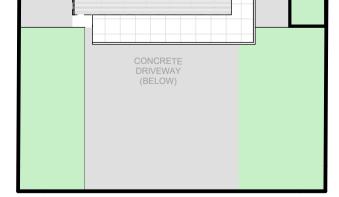

# **BASIX REQUIREMENTS**

### CERTIFICATE NUMBER: 1291880S

## STORMWATER

RECYCLED WATER AREA: NO RAINWATER TANK SIZE: 3000L USES: LANDSCAPING TANK WATER OVERFLOW: STREET K&G


### WATER

SHOWERHEAD RATING: 4 STAR MIN TOILET RATING: 5 STAR MIN BATHROOM TAP RATING: 5 STAR MIN KITCHEN TAP RATING: 5 STAR MIN

THERMAL COMFORT INTERNAL WALLS: PLASTERBOARD EXTERNAL WALLS: CAVITY BRICK EXTERNAL INSULATION: R2.0 BATTS CEILING INSULATION: R3.5 BATTS ROOF VENTILATORS: 4 WIND VENTILATORS ROOF INSULATION: FOIL GLAZING: STANDARD GLASS, CLEAR

### ENERGY


HOT WATER SYSTEM: GAS 5 STAR LIGHTING : LED OR FLUORESCENT **AIRCONDITIONING: 3 PHASE** COOKTOP: GAS CLOTHESLINE: YES NOTE : ALL LED DOWNLIGHTS TO BE INSTALLED WITH APPROVED HEATSHIELDS.

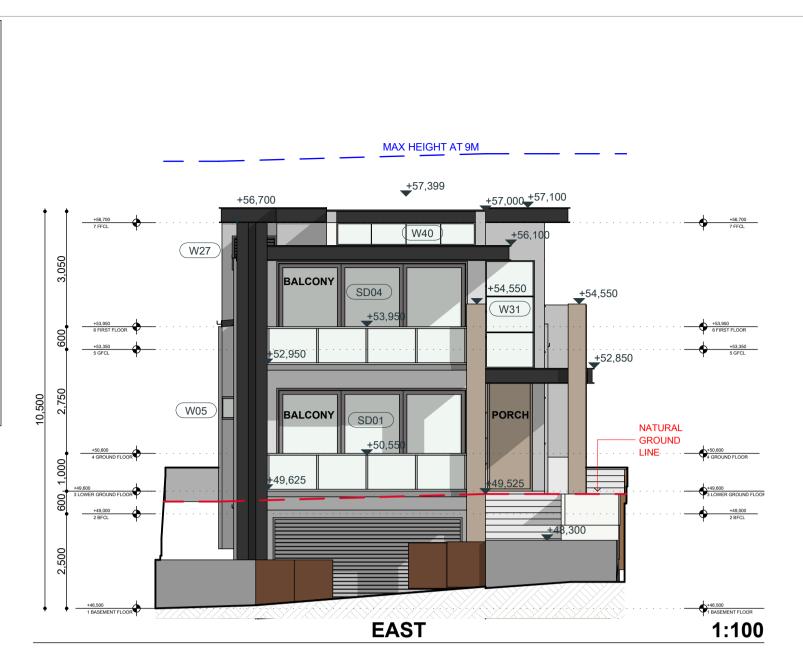










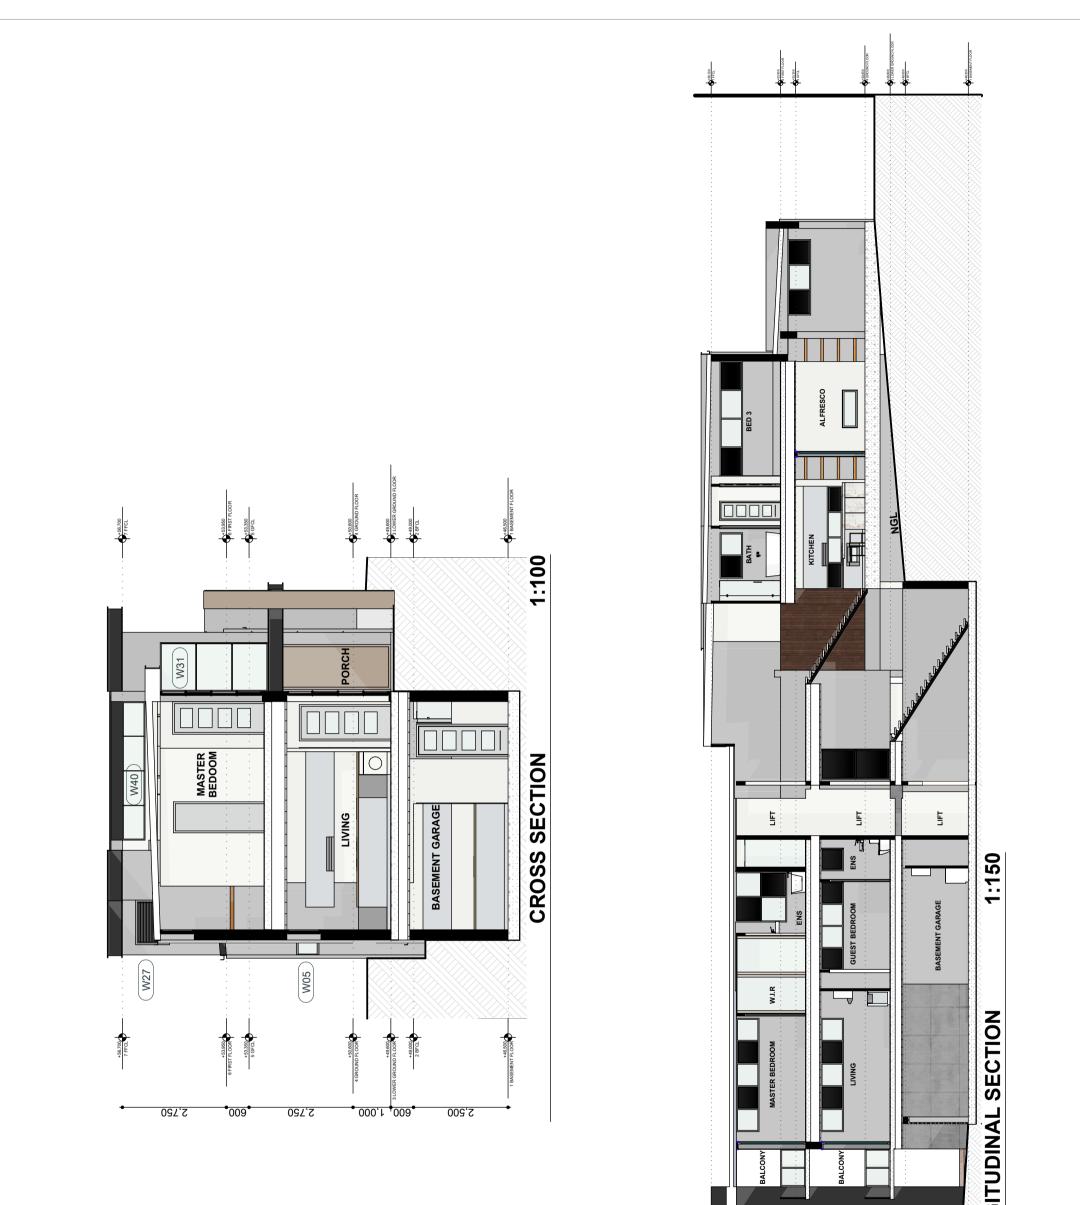

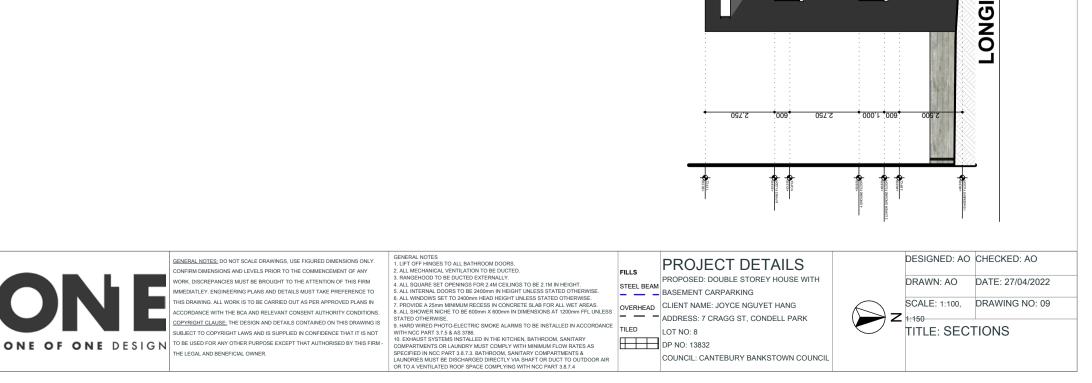

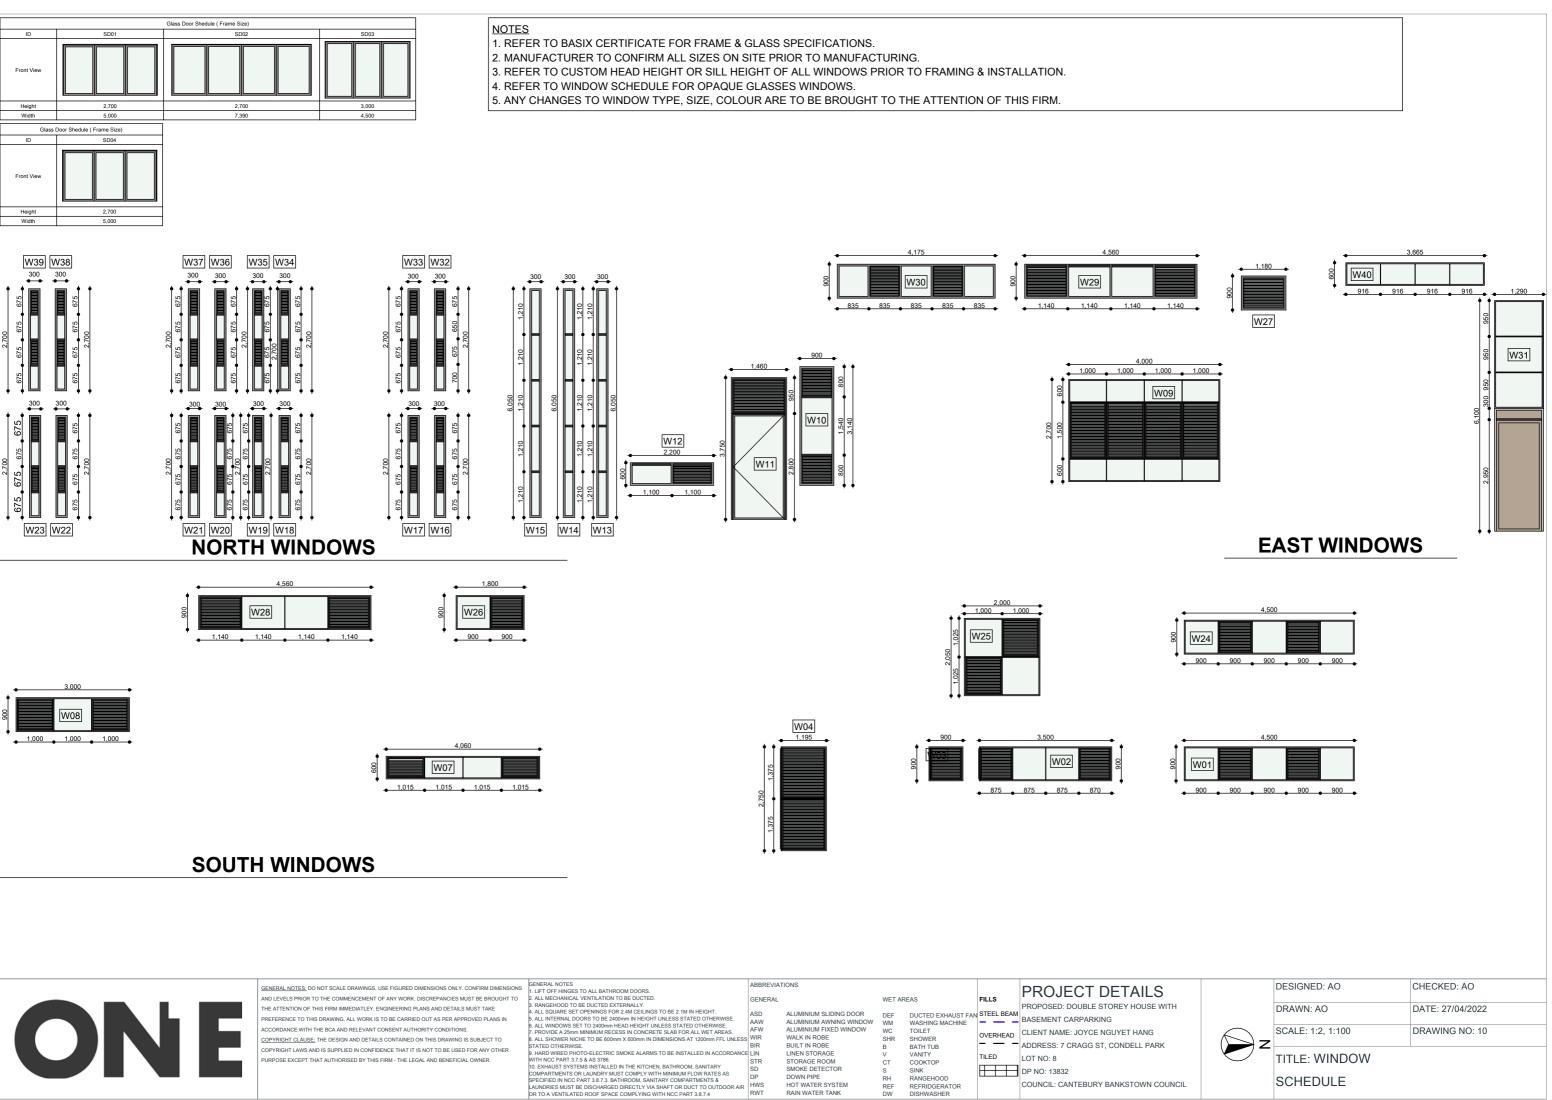


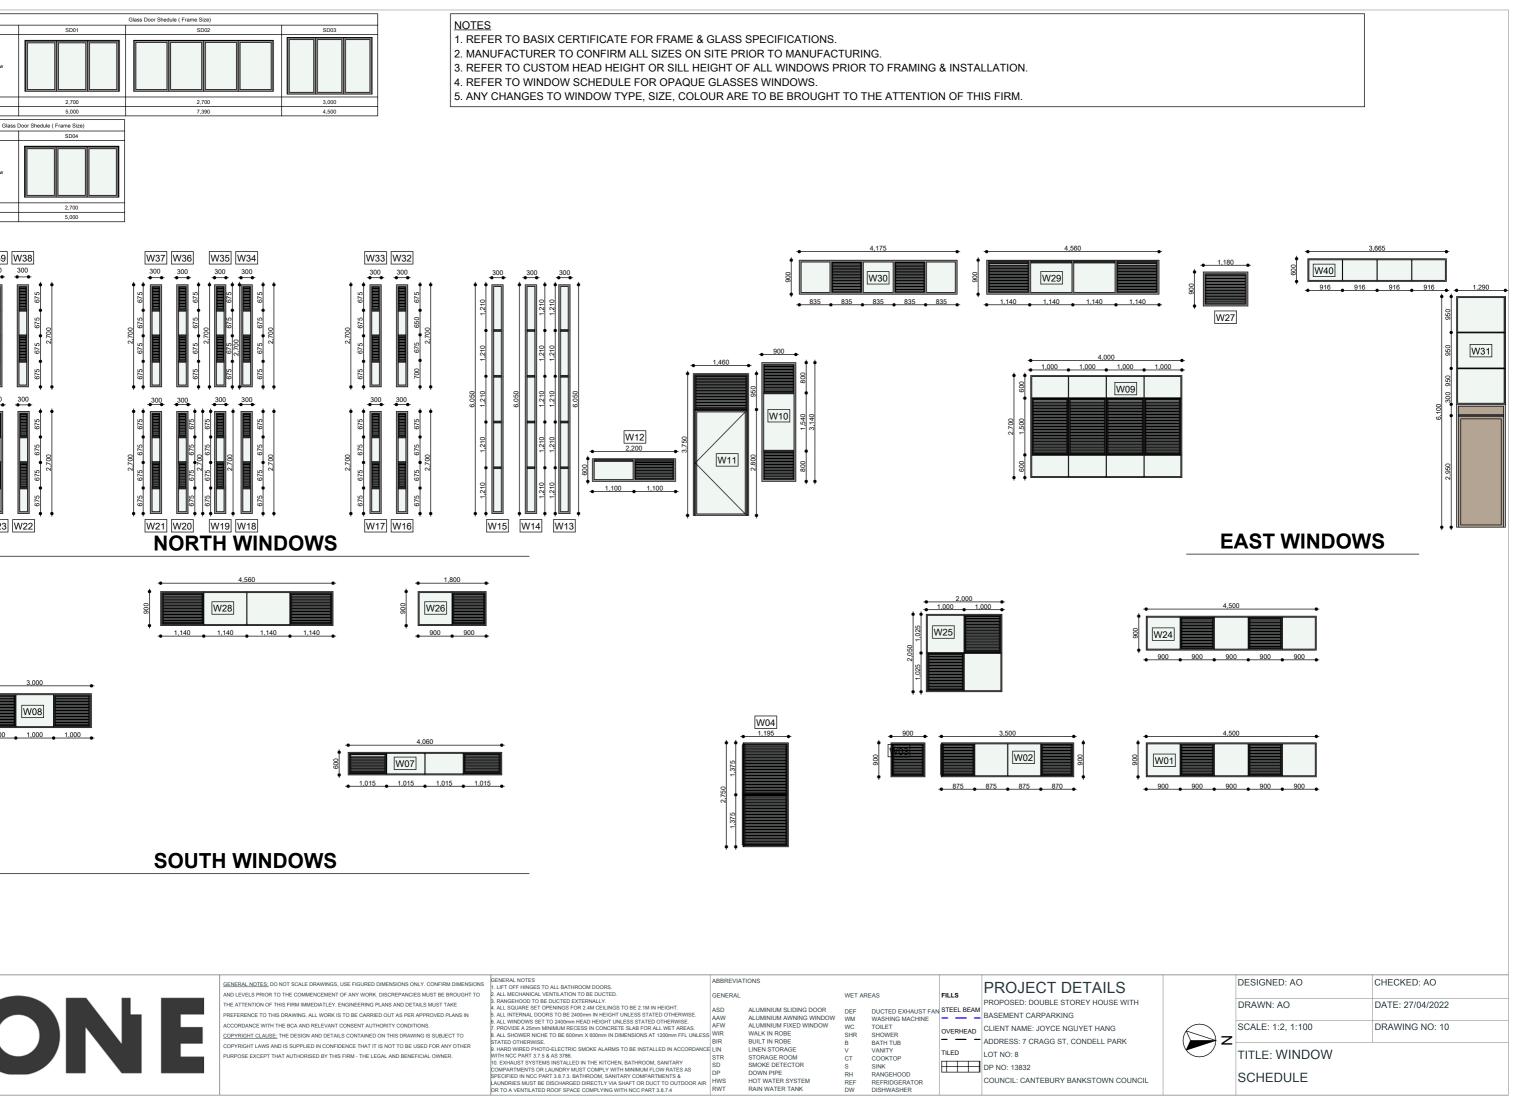



MAIN WALL 1 DULUX LEXICON	‱ ∾ exicon®	FEATURE COLUMNS 2 TIMBER FINISH
MAIN WALL 2 FIBRE CEMENT CLADDING	2	WINDOW FRAMES DULUX TIMLESS GREY OR EQUIVELANT
ROOF COLORBOND WOODLAND GREY OR EQUIVELANT	3	GARAGE DOOR Timeters Grey DULUX TIMLESS GREY OR EQUIVELANT 8
FASCIA / GUTTERS / DOWNPIPES DULUX WOODLAND GREY	4	ENTRY DOOR TIMBER FINISH
FEATURE COLUMNS 1 DULUX RICH BLACK	RICH BLACK	DRIVEWAY TEXTURED CONCRETE 10





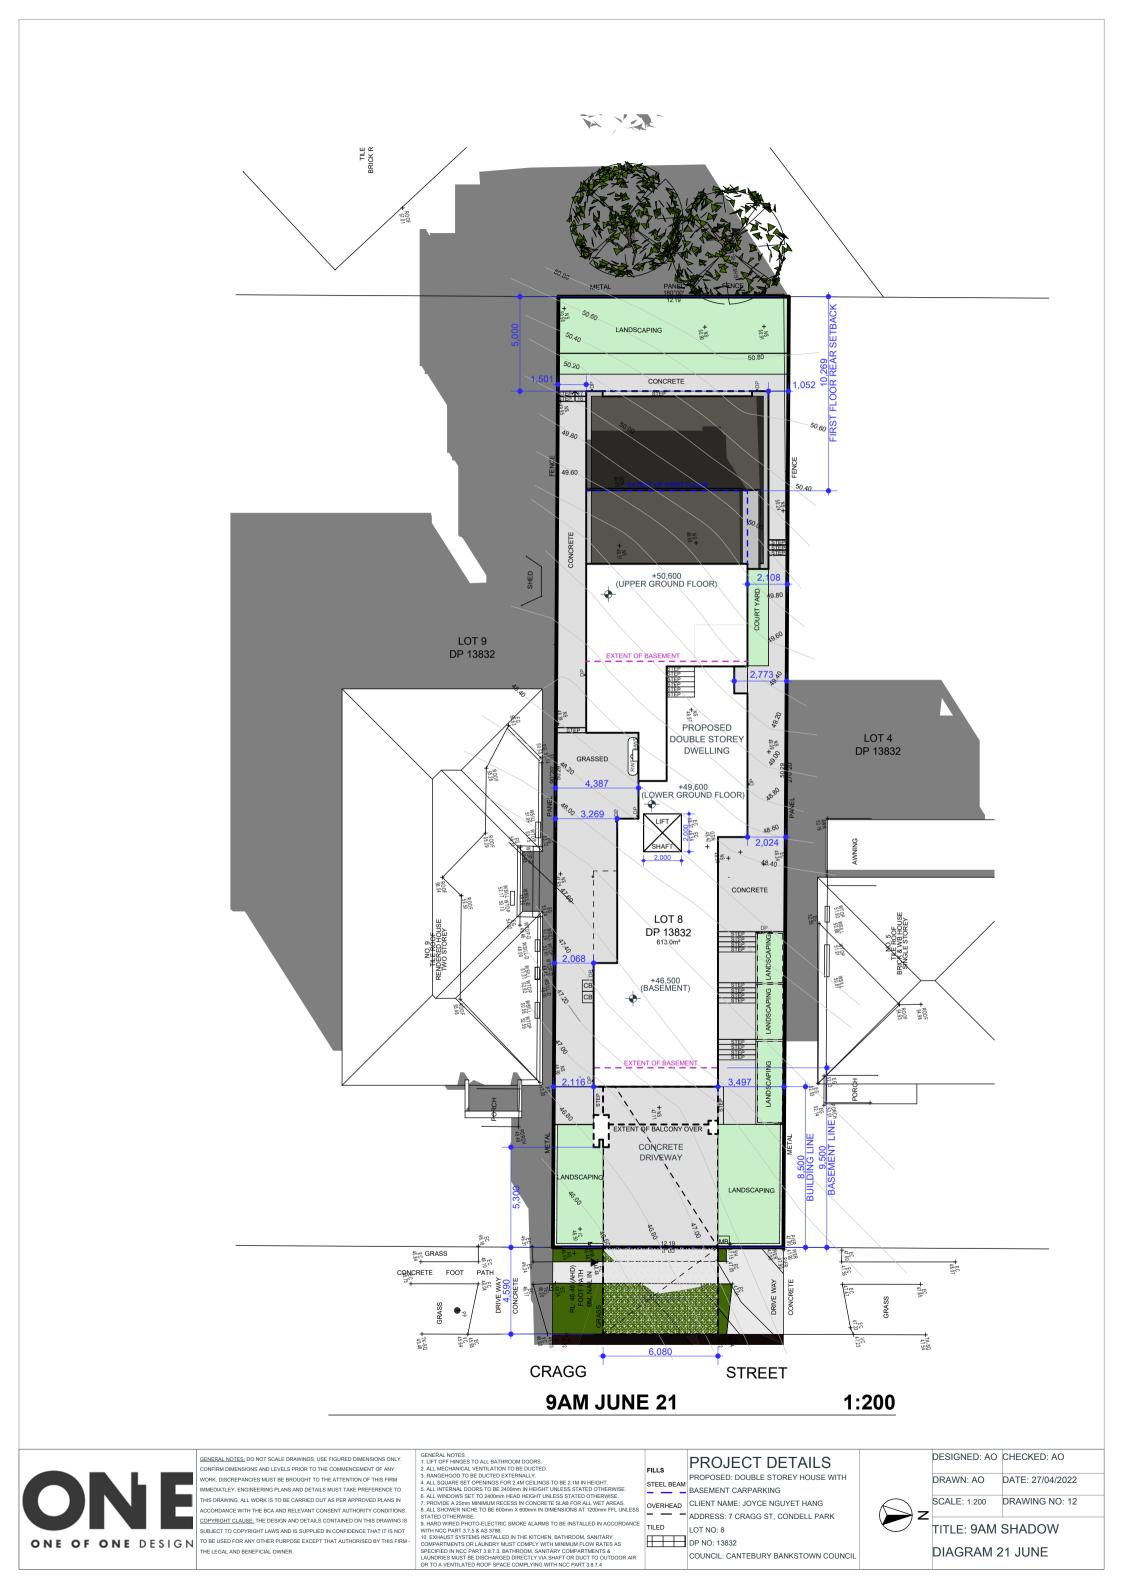

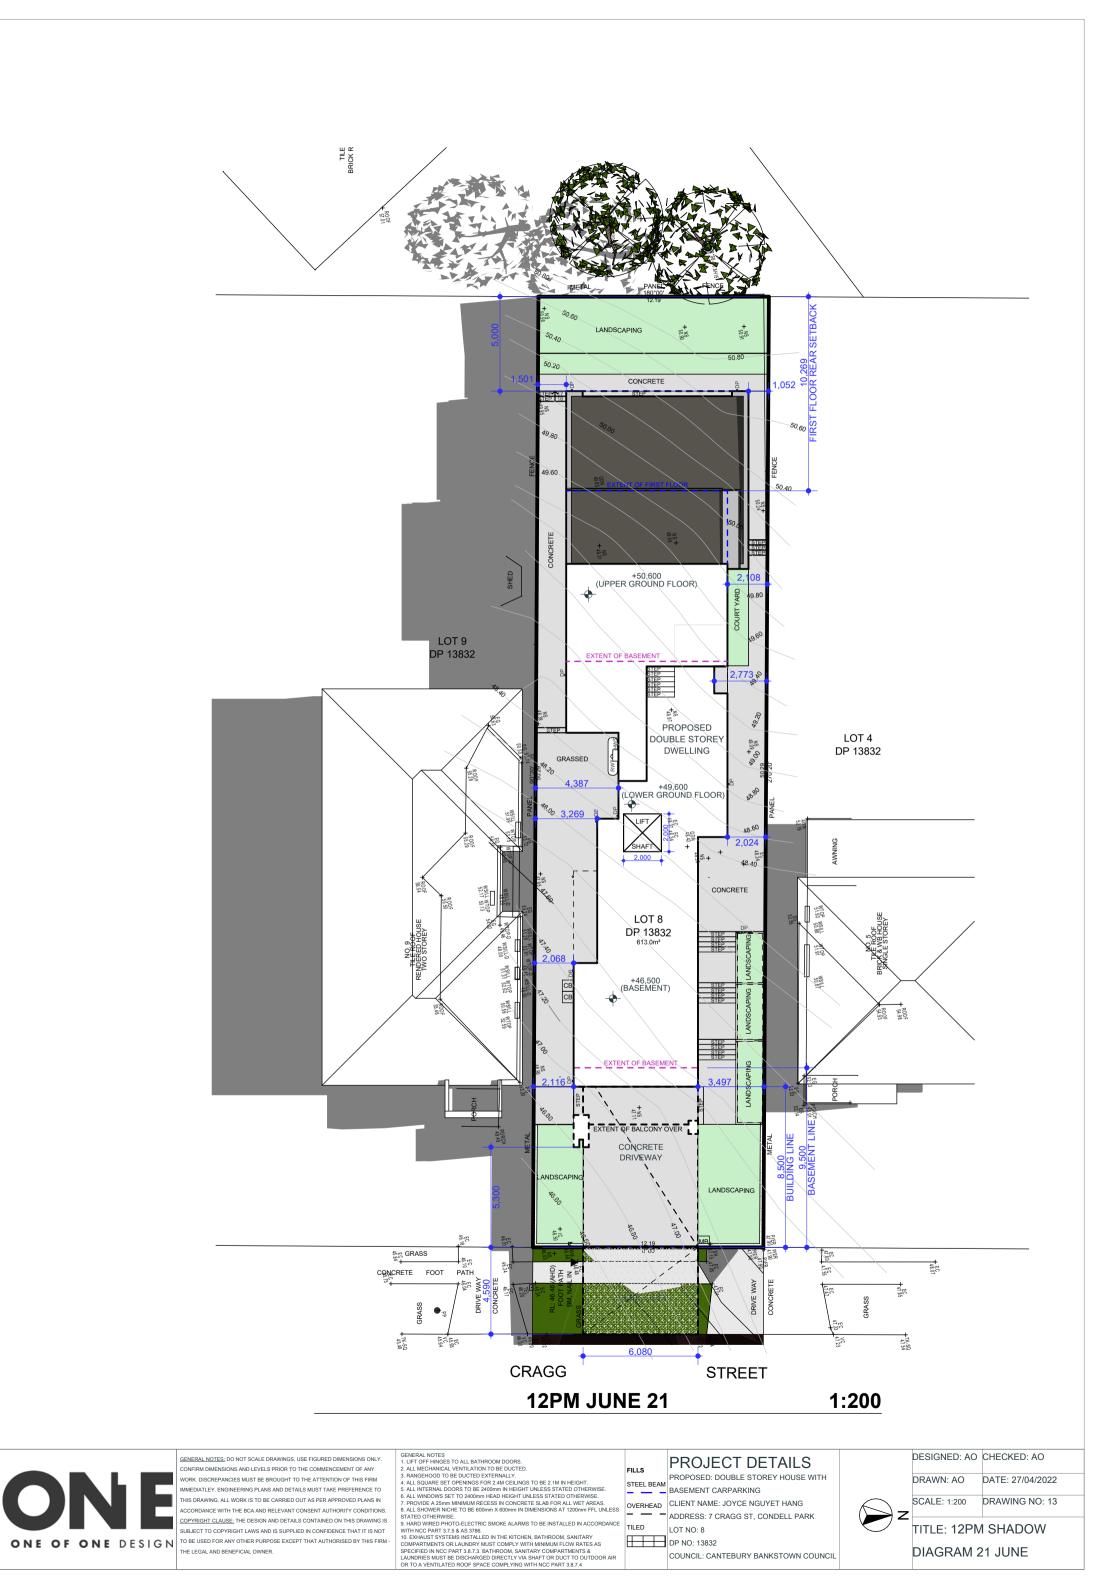

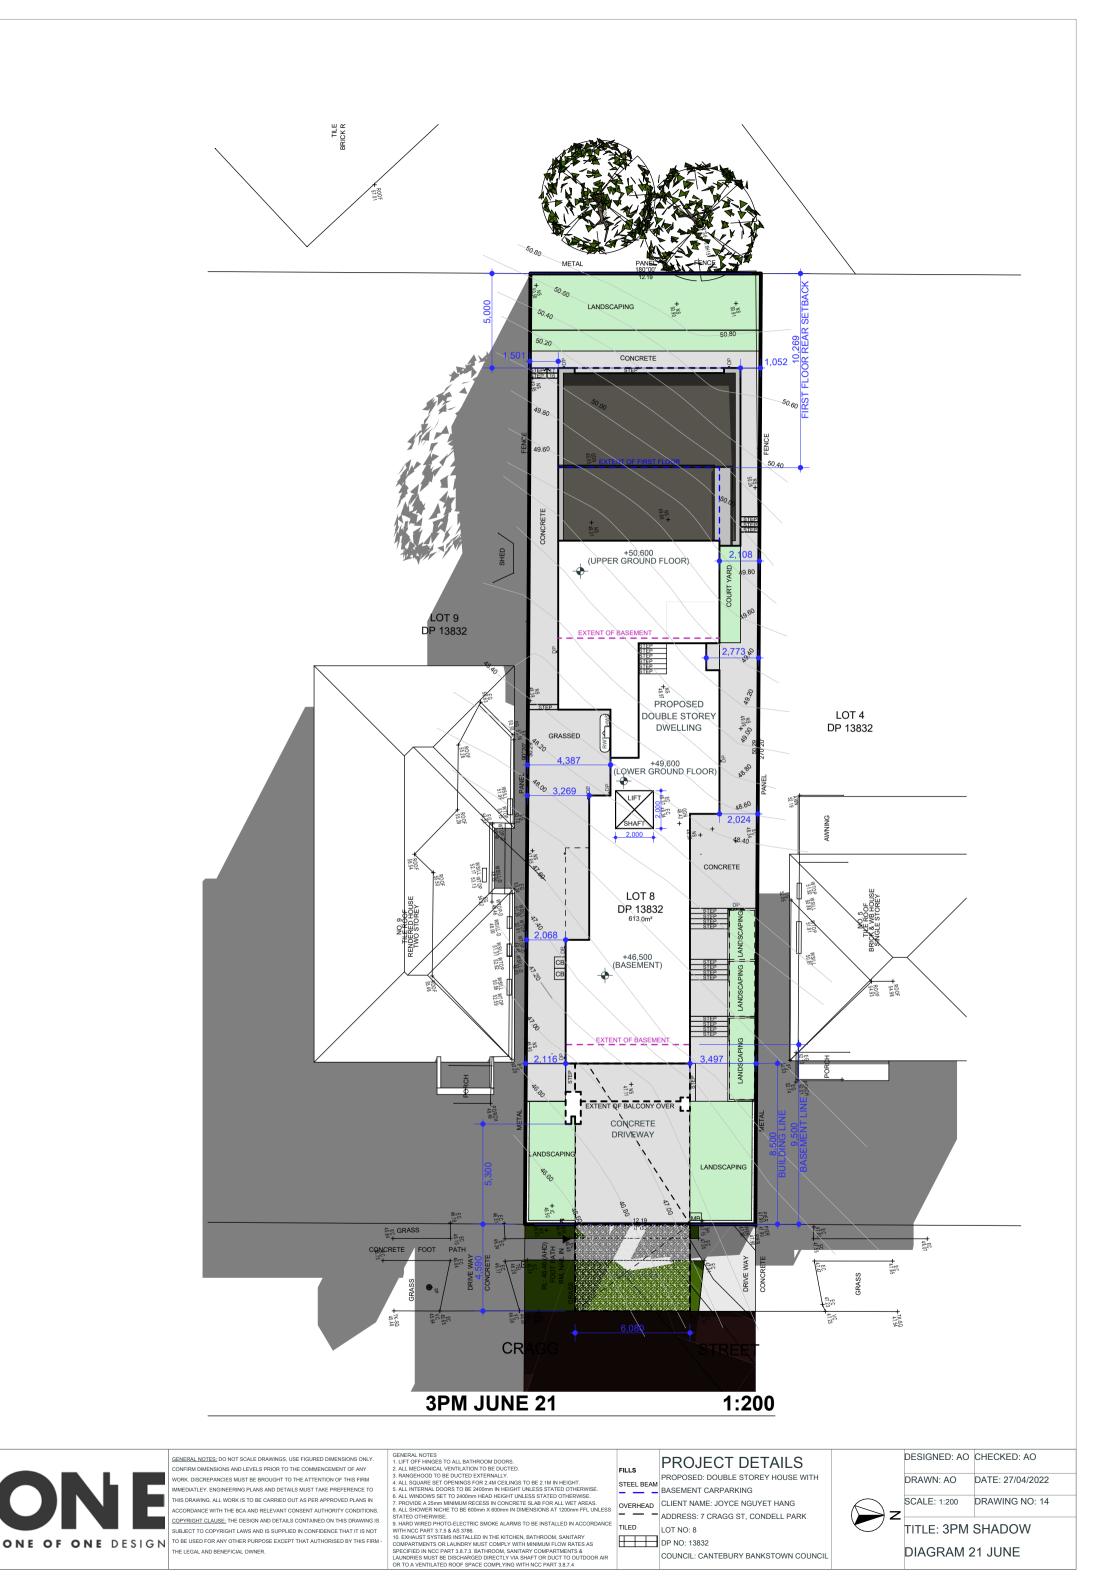

# DEMOLITION MANAGEMENT LEGEND





AREA OF BUILDING TO BE DEMOLISHED

AREA OF BUILDING TO BE MAINTAINED




SECTION OF BUILDING TO BE MAINTAINED

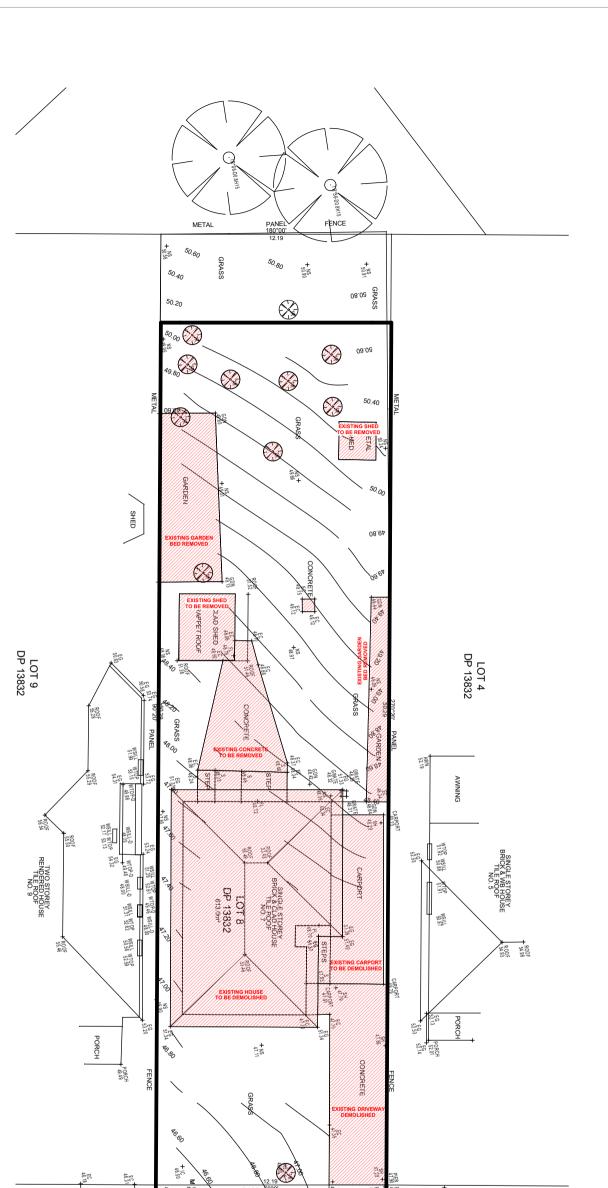


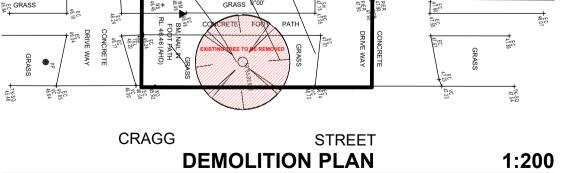




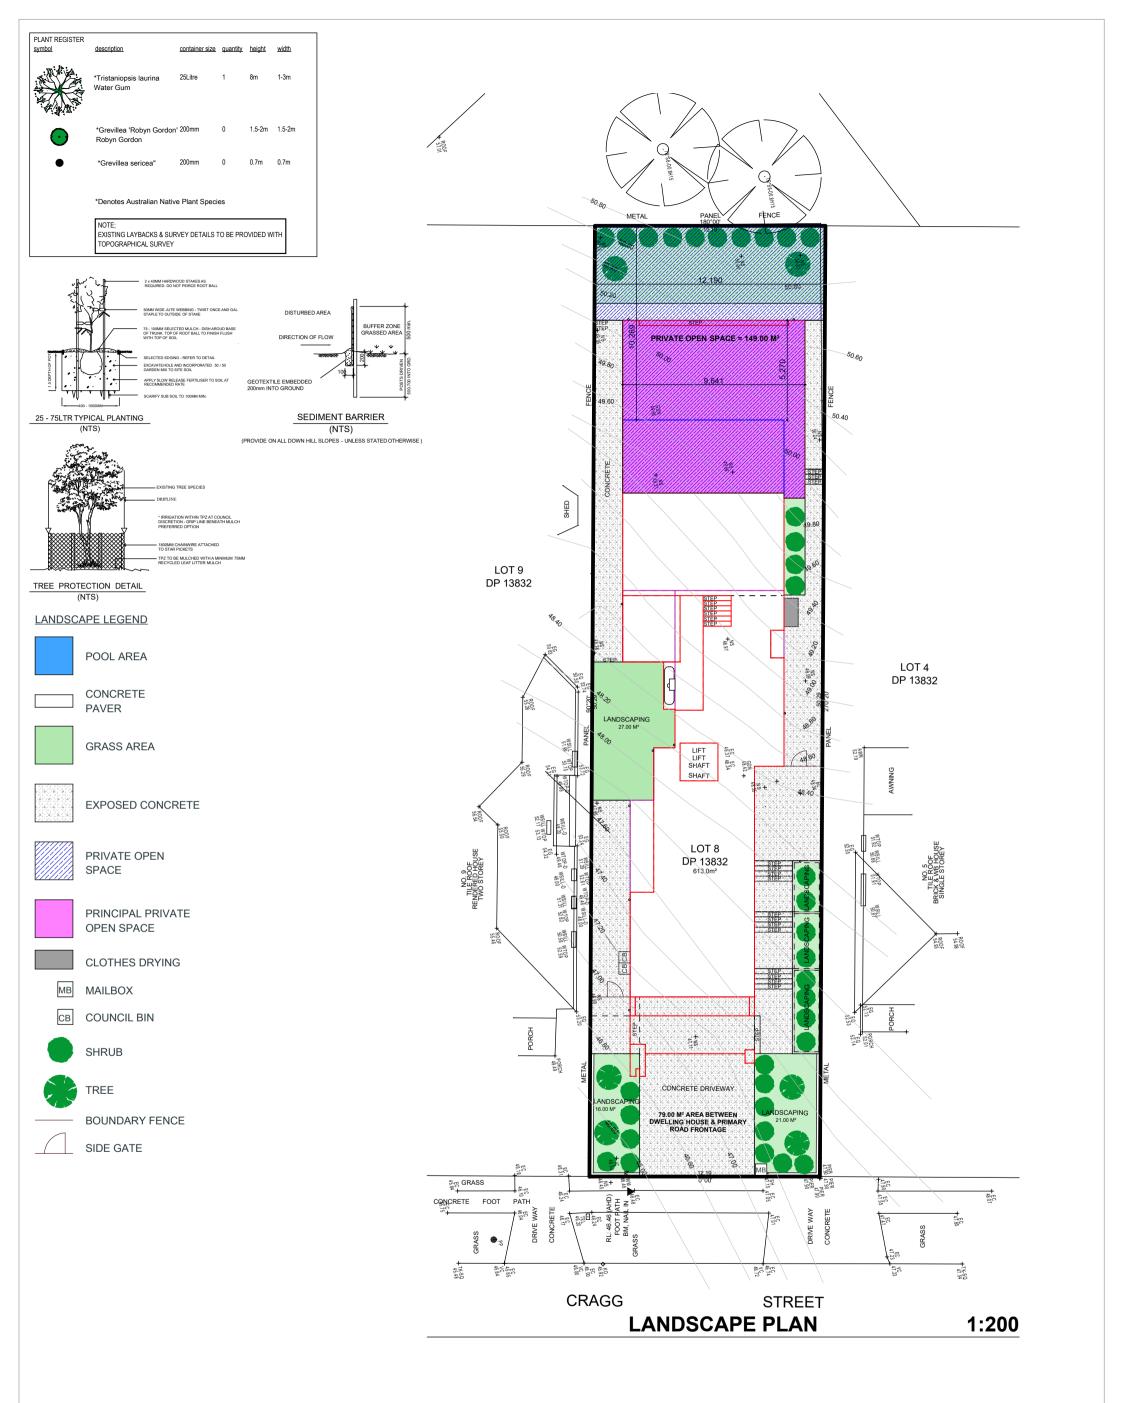



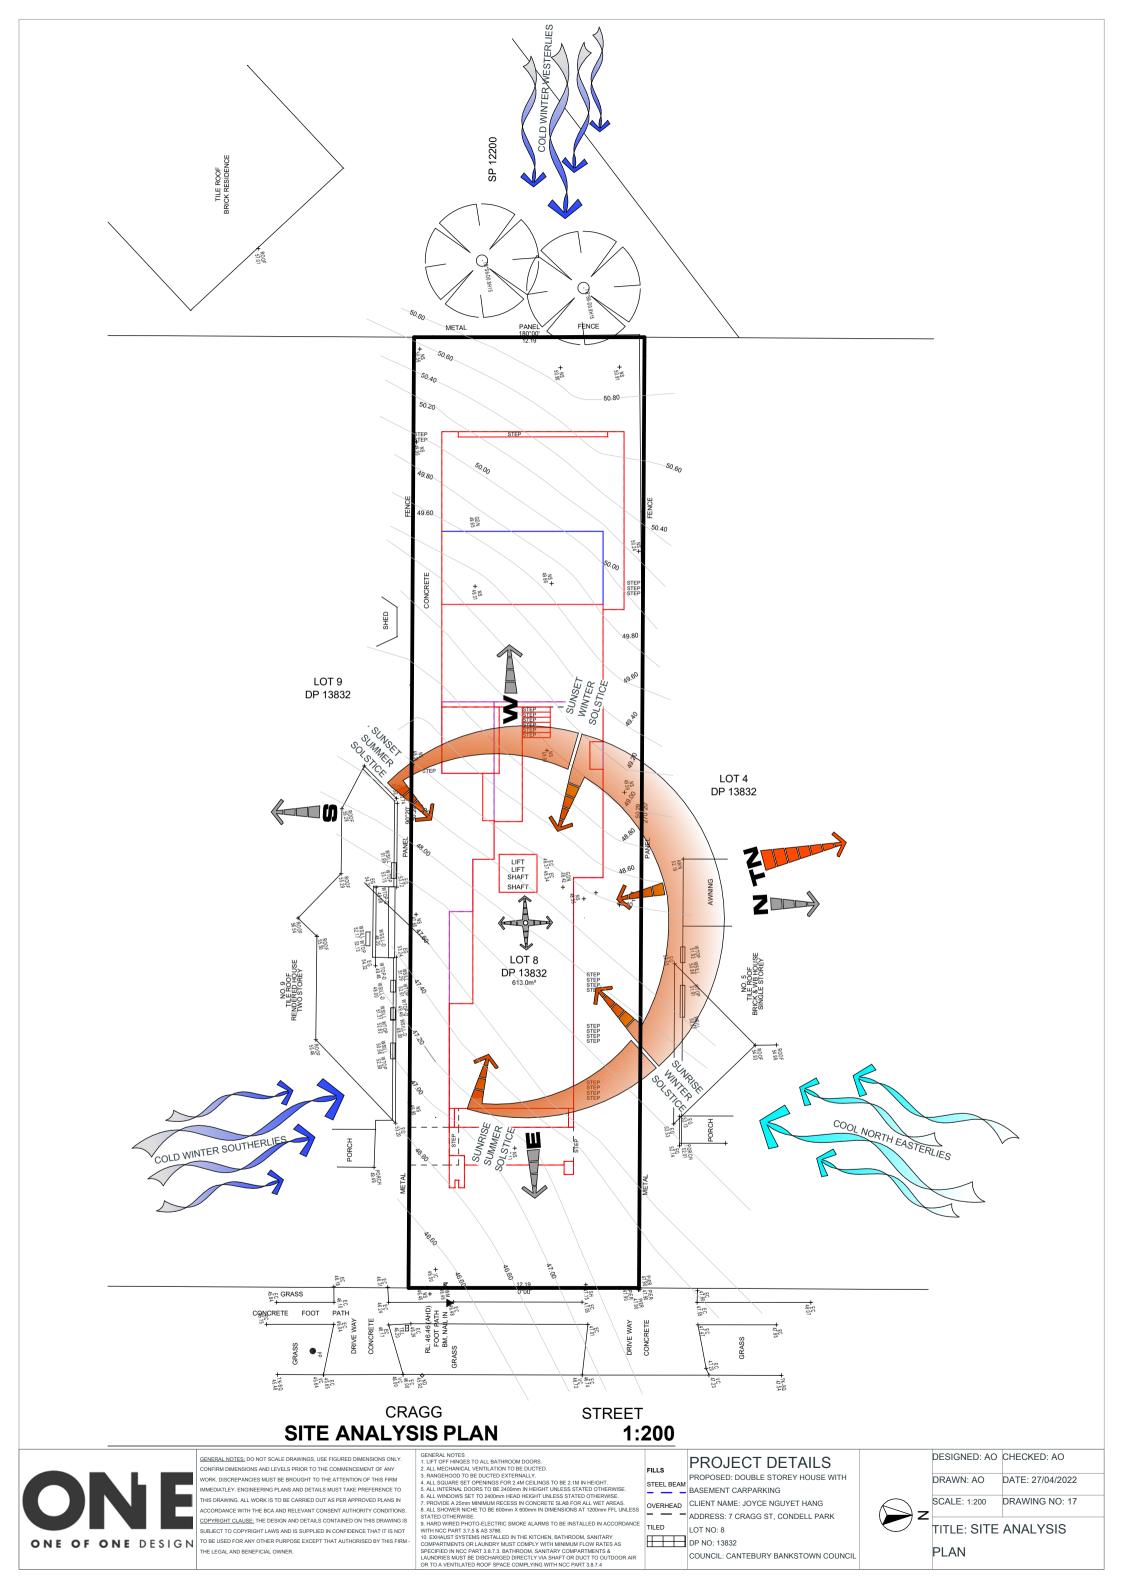



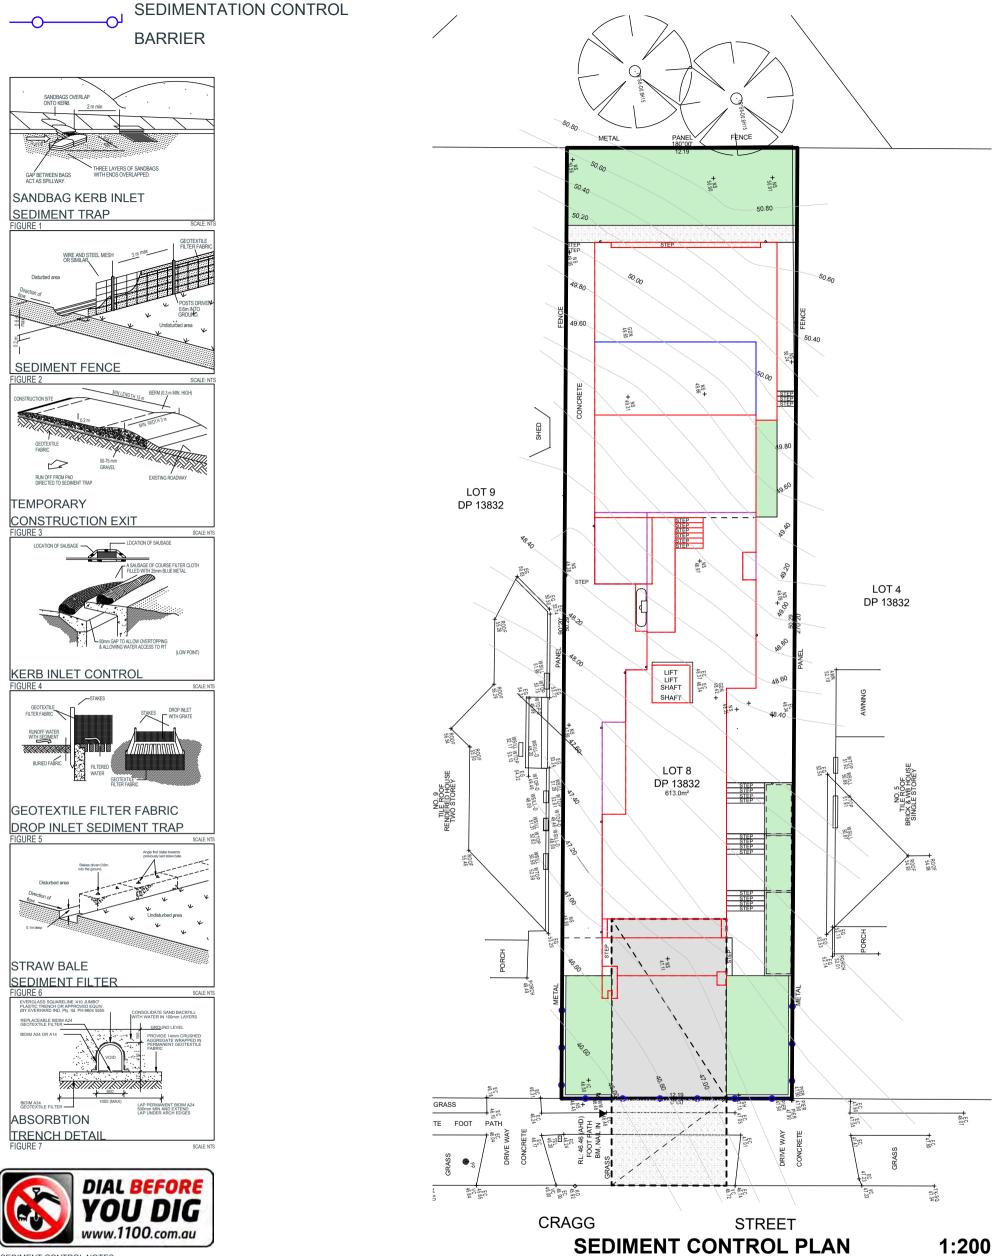

	/ BOOK BITON	
	TRENCH DETAIL	
Ī	FIGURE 7	SCALE:



SEDIMENT CONTROL NOTES:

1. All erosion and sedimentation control measures, including revegetation and storage of soil and topsoil, shall be implemented to the standards of the soil conservation of NSW.

2. All drainage works shall be constructed and stabilized as early as possible during development.

3. Sediment traps shall be constructed around inlet pits, consisting of 300mm wide x 300mm deep trench.


4. All sediment basins and traps shall be cleaned when the structures are a maximum of 60% full of soil materials, including maintenance period.

5 All disturbed areas shall be revegetated as soon as the relevant works are completed


6. Soil and topsoil stockpiles shall be located away from drainage lines and area where water may concentrate.

7. Filters shall be constructed by stretching fabric (propex) or approved equivelant between post and 3.0m centres. Fabric shall be buried 150mm along its lower edge



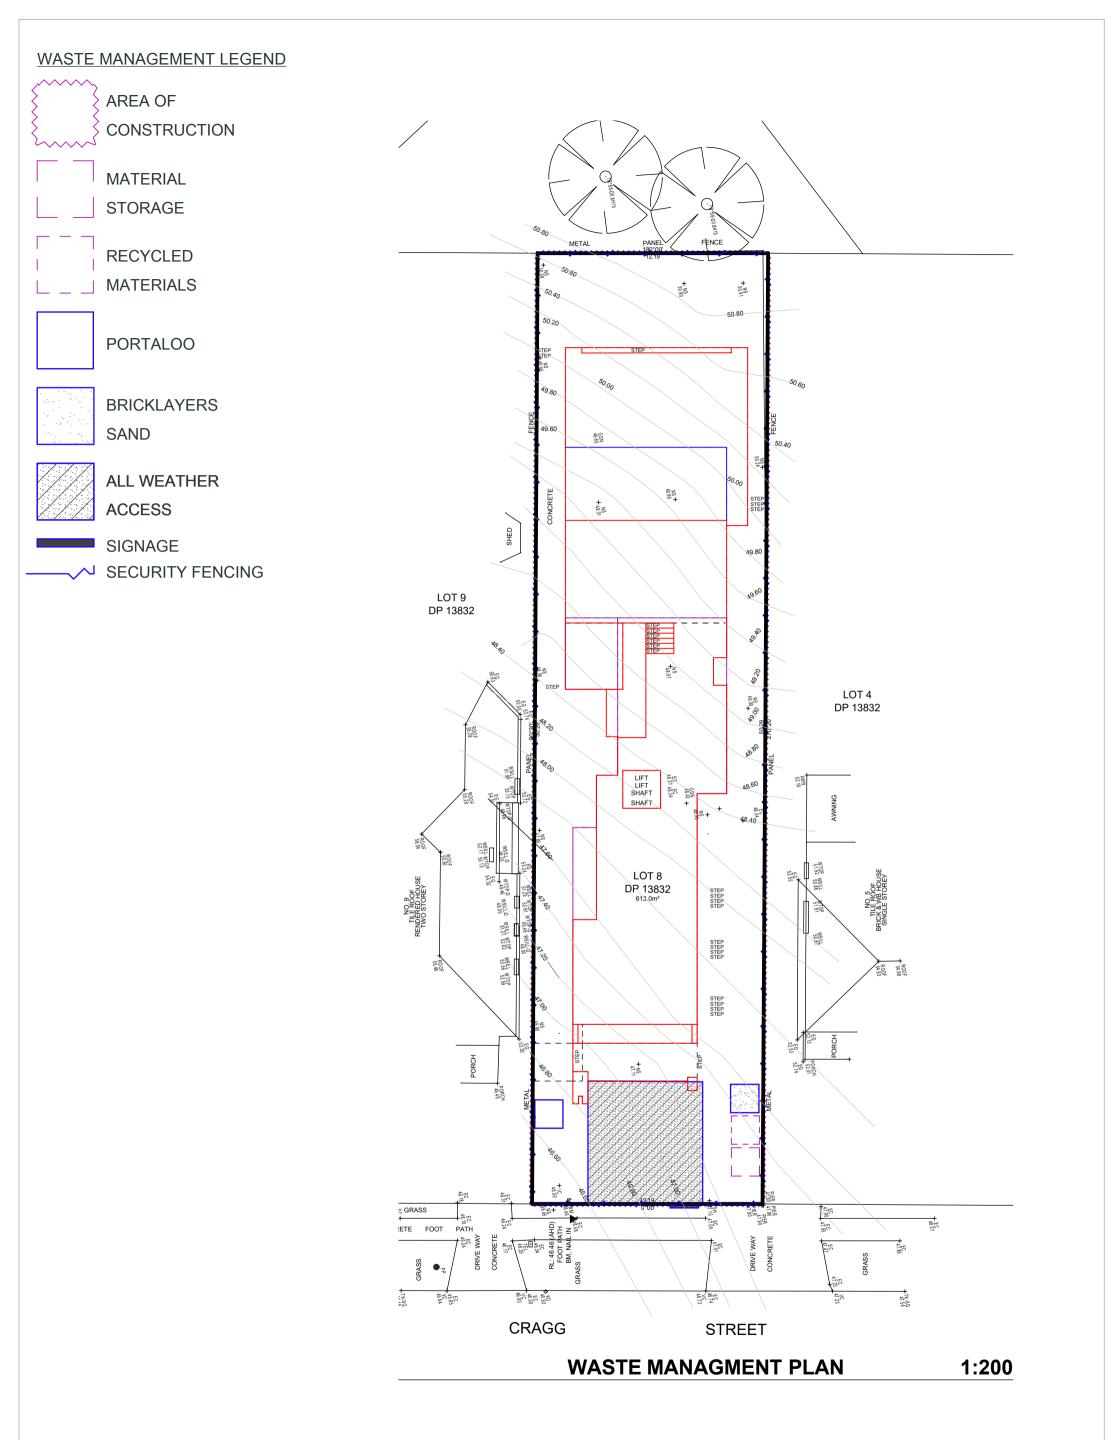





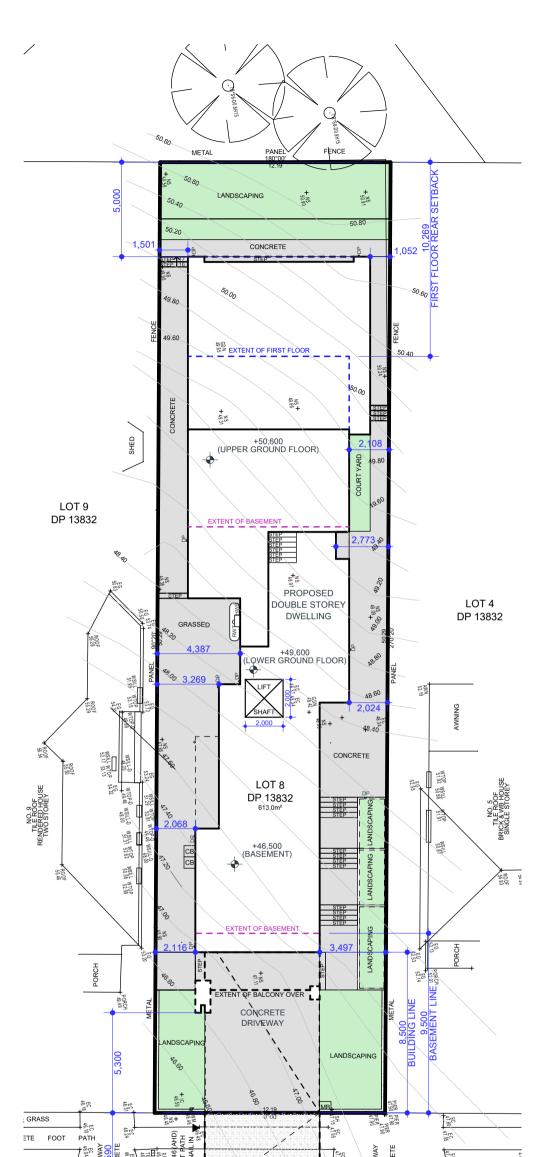





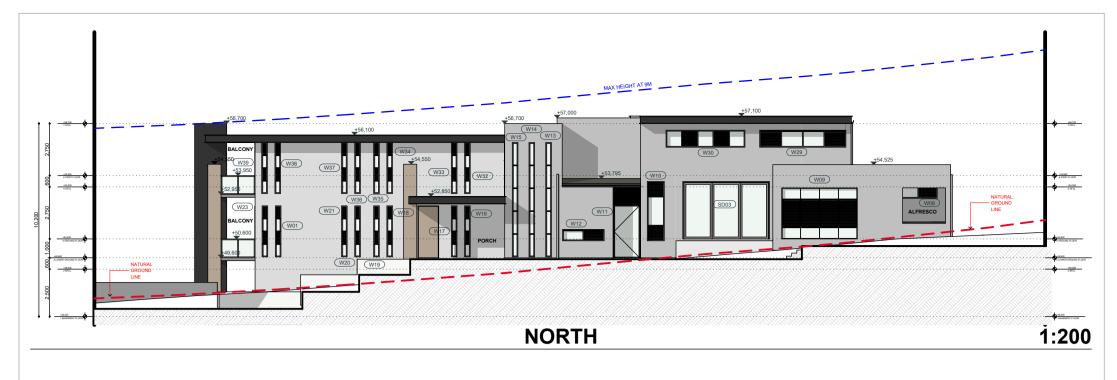

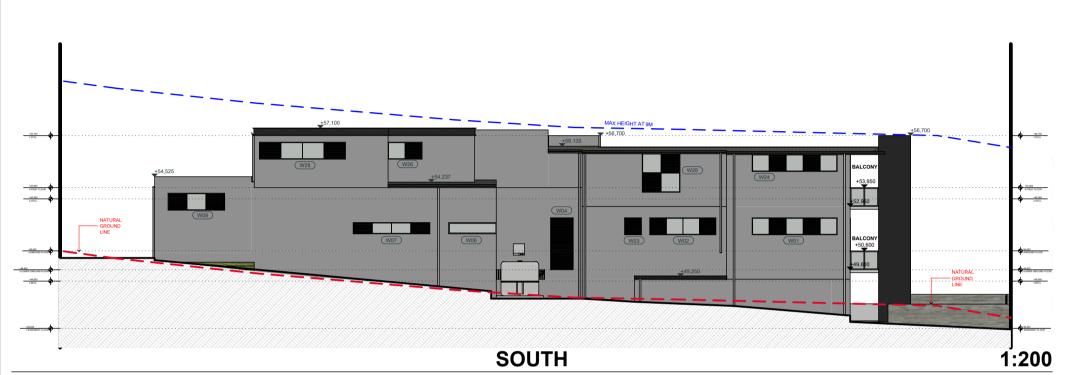



MAX HEIGHT AT 9M



